

NOTES

1. THIS SITE HAS WIRELESS NBN Co COVERAGE. NBN Co SATELLITE DISH TO BE SUPPLIED AND INSTALLED BY NBN Co CONTRACTOR.
- 1.1. PROVIDE A DOUBLE POWER OUTLET ADJACENT TO THE IFL WALL OUTLET AT THE PROPOSED LOCATION OF NBN CONNECTION BOX.
2. ALIGNMENT OF NEW CONDUITS SHOWN FOR DESIGN INTENT. LIAISE WITH PRINCIPLE CONTRACTOR AND CONFIRM ROUTES PRIOR TO INSTALLATION.
3. THE CONTRACTOR SHALL LIAISE WITH ERGON AND NBN Co FOR THE TIMING OF THE NEW WORKS.
4. PROVIDE A FREE-TO-AIR TV SATELLITE / SYSTEM.
- 4.1. FINAL SATELLITE LOCATION TO BE CONFIRMED ON SITE. SITUATED WHERE THE STRONGEST SIGNAL WILL BE RECEIVED.

SCALE 1:200 AT A3



REPRODUCTION OF DRAWINGS
THIS DRAWING HAS BEEN DOCUMENTED IN COLOUR
AS SUCH, THIS DRAWING IS REQUIRED TO BE PRINTED IN COLOUR.
FAILURE TO DO SO MAY RESULT IN LOSS OF INFORMATION

GENERAL NOTES:

THIS PLAN HAS BEEN PREPARED IN ACCORDANCE WITH ALL RELEVANT BUILDING CODES AND STANDARDS. NO AMENDMENTS SHALL BE MADE WITHOUT THE APPROVAL FROM THE DESIGNER AND THE CLIENT. THESE DRAWINGS ARE SUPPLIED ON THE CONDITION THAT IN THE EVENT OF ERROR THE DESIGNERS LIABILITY IS LIMITED ONLY TO THE COST OF AMENDING THESE DRAWINGS.

CONTRACTORS ARE TO VERIFY ALL DIMENSIONS ON SITE BEFORE COMMENCING ANY WORK OR PRODUCING SHOP DRAWINGS. THESE DRAWINGS ARE PROTECTED BY THE LAWS OF COPYRIGHT AND MAY NOT BE COPIED OR REPRODUCED WITHOUT THE WRITTEN PERMISSION OF THE DESIGNER.

REVISION SCHEDULE

NO.	DESCRIPTION	DATE
P1	PRELIMINARY ISSUE	18/04/24
A	TENDER ISSUE	24/05/24
0	CONSTRUCTION ISSUE	03/09/24

CLIENT

NORTH PENINSULA AREA
REGIONAL COUNCIL



PROJECT DESCRIPTION

COMMUNITY HOUSING

BUILDING SERVICES ENGINEERS

TOOWOOMBA OFFICE
PO BOX 1971
2 KIRK STREET
TOOWOOMBA QLD 4350
07 4512 6300


BRISBANE OFFICE
12B, 661 OXLEY ROAD,
CORINDA, QLD, 4075
07 4512 6300

www.diametric.com.au
reception@diametric.com.au

DESIGNER AC	DRAWN BY KC	CHECKED BY AC
APPROVED	RPEQ	DATE

DISCIPLINE
ELECTRICAL SERVICES
DRAWING TITLE
SITE PLAN - 326 POI POI ST

PROJECT NUMBER	DRAWING NUMBER	REVISION
DE230925	E013	0

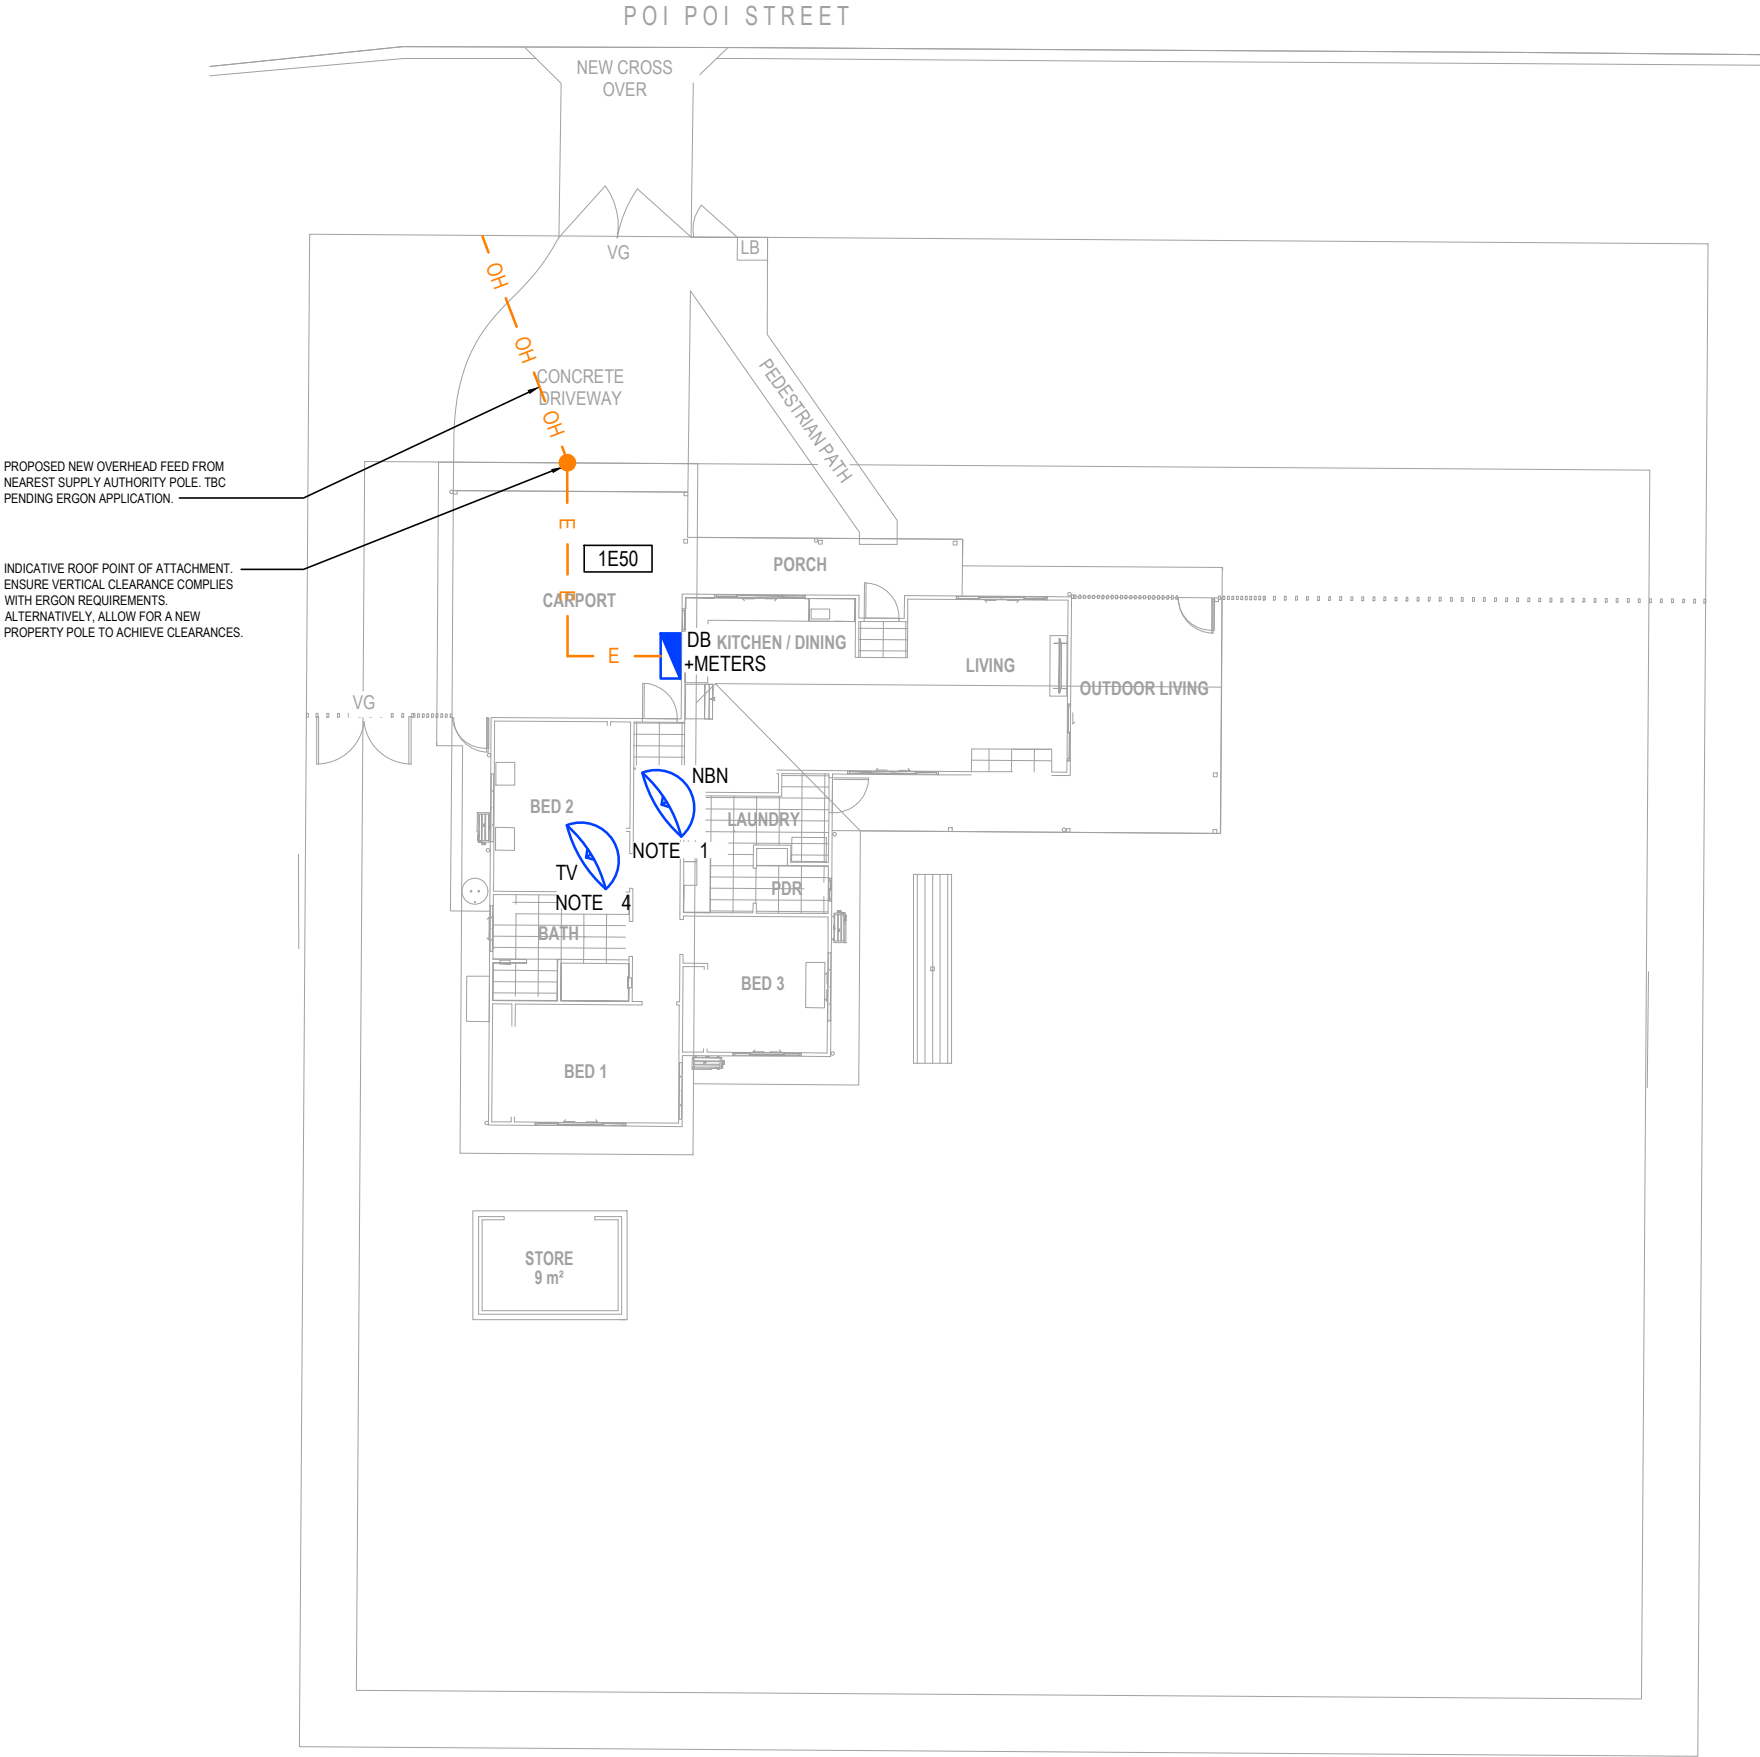

CONSTRUCTION